

# WEST BRANCH - ROSE CITY AREA SCHOOLS

## SF1.5 - ROSE CITY ELEMENTARY SCHOOL DDC CONTROLS

### WEST BRANCH, MICHIGAN

#### PROJECT DESCRIPTION

IN GENERAL, WORK OF THE CONTRACT INCLUDES:  
1. REPLACEMENT OF EXISTING HVAC EQUIPMENT CONTROLS WITH NEW  
DDC CONTROLS.


#### BUILDING DATA

APPLICABLE CODES  
2015 MICHIGAN CODE SERIES  
2012 NFPA 101 LIFE SAFETY CODE  
USE AND OCCUPANCY CLASSIFICATION  
USE GROUP E – EDUCATIONAL  
CONSTRUCTION TYPE  
MBC CONSTRUCTION TYPE IB  
ASCE 7-16 CONSTRUCTION TYPE II(000)  
BUILDING AREA  
39,700sf  
FIRE SUPPRESSION  
None  
OCCUPANT LOAD (ACTUAL)  
STUDENTS: 160  
STAFF: 35

#### SHEET INDEX

T TITLE SHEET / PROJECT INFORMATION  
M1.1 FLOOR PLAN PART "A" – MECHANICAL  
M1.2 FLOOR PLAN PART "B" – MECHANICAL

**ANTHONY P. ESSON  
ARCHITECT**  
PO BOX 479  
GAYLORD, MICHIGAN 49734  
TELEPHONE: (989)732-0585

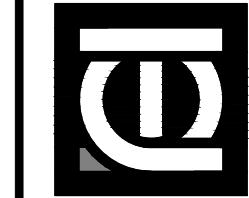

DRAWING TITLE  
TITLE SHEET  
PROJECT INFORMATION

PROJECT NO.  
263-18M  
PROJECT TITLE  
WEST BRANCH - ROSE CITY AREA SCHOOLS  
SF1.5 - ROSE CITY ELEMENTARY DDC CONTROLS  
WEST BRANCH, MICHIGAN



SHEET	DATE	PROJECT NO.	PROJECT TITLE
T	DEC 17, 2021	263-18M	WEST BRANCH - ROSE CITY AREA SCHOOLS SF1.5 - ROSE CITY ELEMENTARY DDC CONTROLS WEST BRANCH, MICHIGAN

STATE OF MICHIGAN  
REGISTRATION

CHANGE TO PLANS AND SPECIFICATIONS  
AN ORDER CHANGES A DRAWING, WHETHER BY THE OWNER, ARCHITECT, OR CONTRACTOR, OR ANY OTHER PARTY OF ANY OF THE CONTRACT DOCUMENTS IS SUBMITTED BY THE DESIGNER, SHALL NOT BE BINDING UPON OR UNLESS THE SAME IS APPROVED IN WRITING BY THE OWNER, ARCHITECT, OR CONTRACTOR, OR ANY OTHER PARTY, WITHOUT THE WRITTEN APPROVAL OF THE ENGINEER, AND HELD IN RESERVE FOR THE DESIGNER'S CONSIDERATION. THE DESIGNER'S APPROVAL OF THE SAME SHALL NOT BE DEEMED AS AN ACCEPTANCE OF THE SAME, UNLESS THE SAME IS APPROVED IN WRITING BY THE OWNER, ARCHITECT, OR CONTRACTOR, OR ANY OTHER PARTY.  
THE PROPERTY OF THE DESIGNER AND USE NOT TO BE REQUIRED AND REVERSED AS WRITTEN PERIODICALLY BY THE OWNER, ARCHITECT, OR CONTRACTOR, OR ANY OTHER PARTY.  
PROJECT NO. 1874 ANNE DR.  
GAYLORD, MI 49734  
Bayshore engineering inc. PO BOX 479  
larry@bayshoreengineering.com

2109-02

**ANTHONY P. ESSON**  
**ARCHITECT**  
PO BOX 479  
GAYLORD, MI 49734  
TELEPHONE: (989) 732-0585

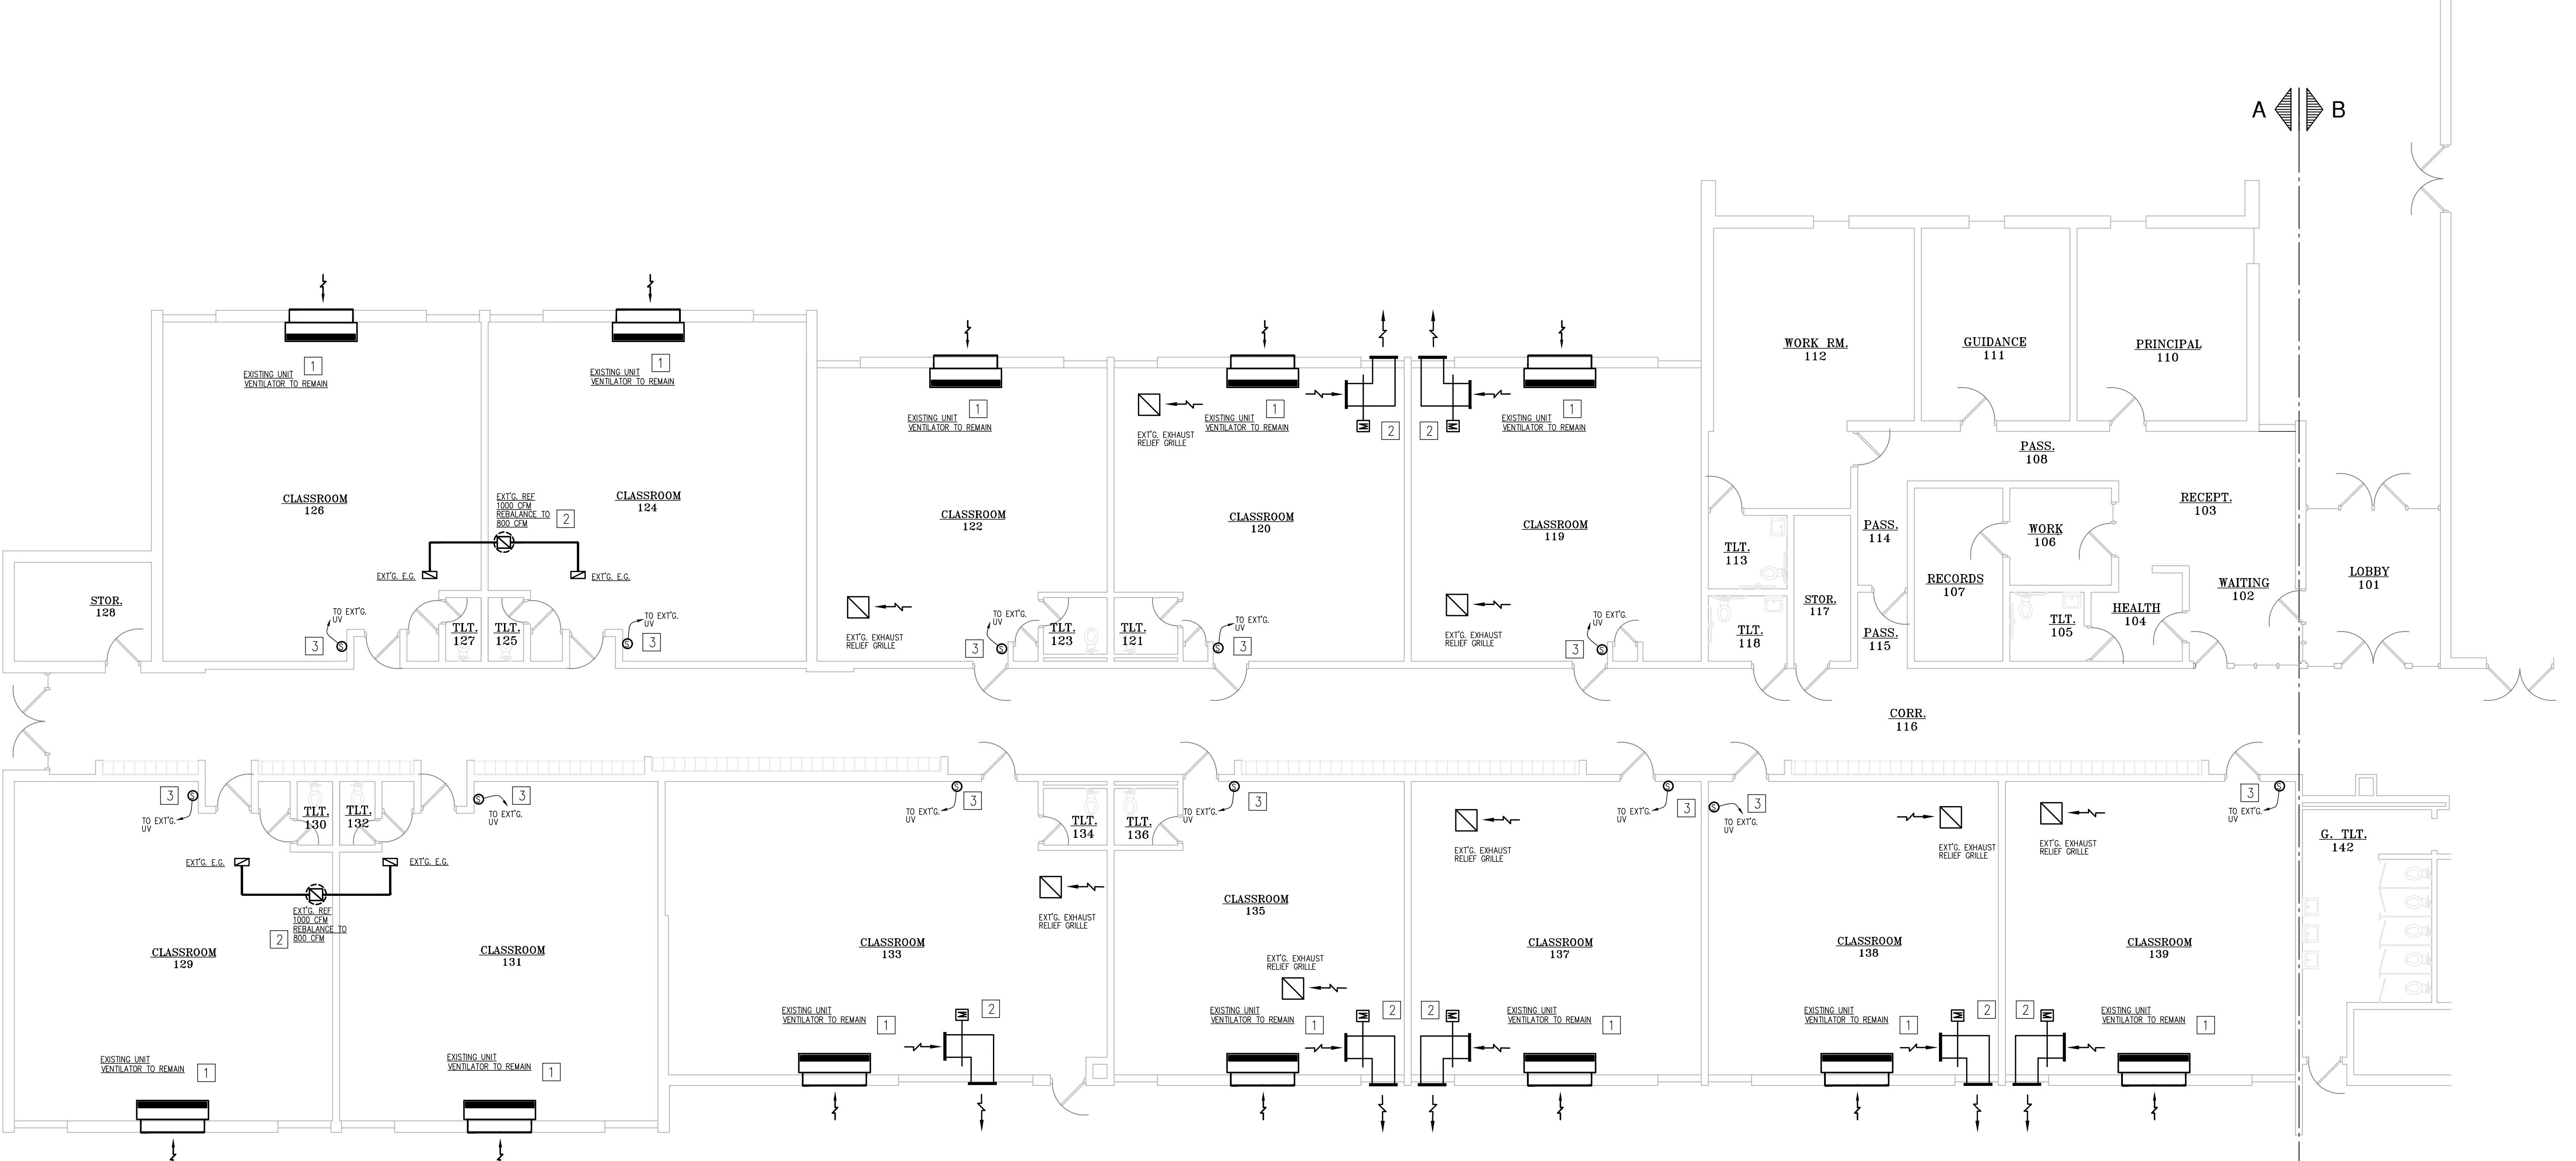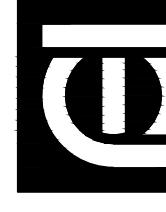

GENERAL MECHANICAL PLAN NOTES:  
1. VERIFY OPERATIONAL CONDITION OF EXISTING EXHAUST FANS/UNIT VENTILATORS AND NOTIFY THE G.C. OF ANY PROBLEMS AND SUGGESTED SOLUTION.  
2. VERIFY OPERATIONAL CONDITION OF EXISTING MOTORIZED DAMPERS AND NOTIFY THE G.C. OF ANY PROBLEMS AND SUGGESTED SOLUTION.



### FLOOR PLAN PART "A" - MECHANICAL

SCALE:

8" = 1'-0"

#### KEYED MECHANICAL PLAN NOTES:

- [1] EXISTING UNIT VENTILATOR W/ YEAR 2000 TRI-CITY CONTROLS. INTEGRATE TO NEW DDC CONTROL SYSTEM, AS REQUIRED.
- [2] INTEGRATE EXISTING UNIT VENTILATOR W/ EXISTING ROOF MOUNTED EXHAUST FAN TO NEW DDC CONTROLS, AS REQUIRED. REBALANCE EXHAUST FAN CFM AS SHOWN.
- [3] REPLACE EXISTING THERMOSTAT WITH NEW WIRELESS ELECTRONIC SENSOR. CONNECT TO NEW TEMPERATURE CONTROL SYSTEM. CAN EXISTING PNEUMATIC PIPING IF APPLICABLE.
- [4] INTEGRATE EXISTING UNIT VENTILATOR W/ EXISTING MOTORIZED RELIEF DAMPER CONTROL AND THE NEW DDC CONTROL SYSTEM AS REQUIRED.

BUILDING BAS SYSTEM:  
THE DIRECT DIGITAL CONTROL SYSTEM IS TO BE PROVIDED BY THE CONTRACTOR. CARRIER REFRIGERATION GATEWAY HAS PROVIDED AND INSTALLED THE CARRIER I-VU BUILDING AUTOMATION SYSTEM UNDER A PREVIOUS CONTRACT. THIS PROJECT WILL BE USING THAT SYSTEM.

**M1.1**

DRAWING TITLE  
FLOOR PLAN - PART "A"  
MECHANICAL

2109-02

263-18M

WEST BRANCH - ROSE CITY AREA SCHOOLS

SF1.5 - ROSE CITY ELEMENTARY DDC CONTROLS


WEST BRANCH, MICHIGAN

CHANGE TO PLANS AND SPECIFICATIONS  
AN ORDER CHANGES A DRAWING OR SPECIFICATION. IT IS THE RESPONSIBILITY OF THE CONTRACTOR TO FOLLOW THE ORDER AS SHOWN. IF ANY OTHER PART OF ANY OF THE PLANS AND SPECIFICATIONS IS CONTRADICTED BY AN ORDER, THE ORDER SHALL BE FOLLOWED. THE CONTRACTOR SHALL NOT BE BOUND BY THE DRAWINGS OR SPECIFICATIONS UNLESS THEY ARE IN CONFLICT WITH THE ORDER. THE CONTRACTOR SHALL NOT BE HELD LIABLE FOR ANY DAMAGES RESULTING FROM THE CONTRACTOR'S COMPLIANCE WITH AN ORDER.

THE PROPERTY OF THE ENGINEER AND USE NOT TO BE REUSED  
AND RETURN TO THE ENGINEER. THIS DRAWING IS THE PROPERTY OF THE ENGINEER.  
ANY CONTRACTOR WHO USES THIS DRAWING MUST PAY AN ANNUAL FEE TO THE ENGINEER.  
THE CONTRACTOR SHALL NOT BE BOUND BY THE DRAWINGS OR SPECIFICATIONS UNLESS THEY ARE IN CONFLICT WITH THE ORDER.

1874 ANNE DR.  
GRAVELING 49276  
PHONE: (231) 459-0005  
engineering inc. CEL (231) 459-0005  
larry@bayshoreengineering.com

PROJECT NO.  
2109-02  
ANTHONY P. ESSON  
ARCHITECT  
GAYLORD, MICHIGAN 49734  
(989) 732-0585  
TELEPHONE:

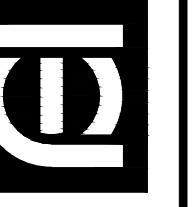


## FLOOR PLAN - PART "B" MECHANICAL


DRAWING TITLE

WEST BRANCH - ROSE CITY AREA SCHOOLS  
SF1.5 - ROSE CITY ELEMENTARY DDC CONTROLS  
WEST BRANCH, MICHIGAN

M1.2

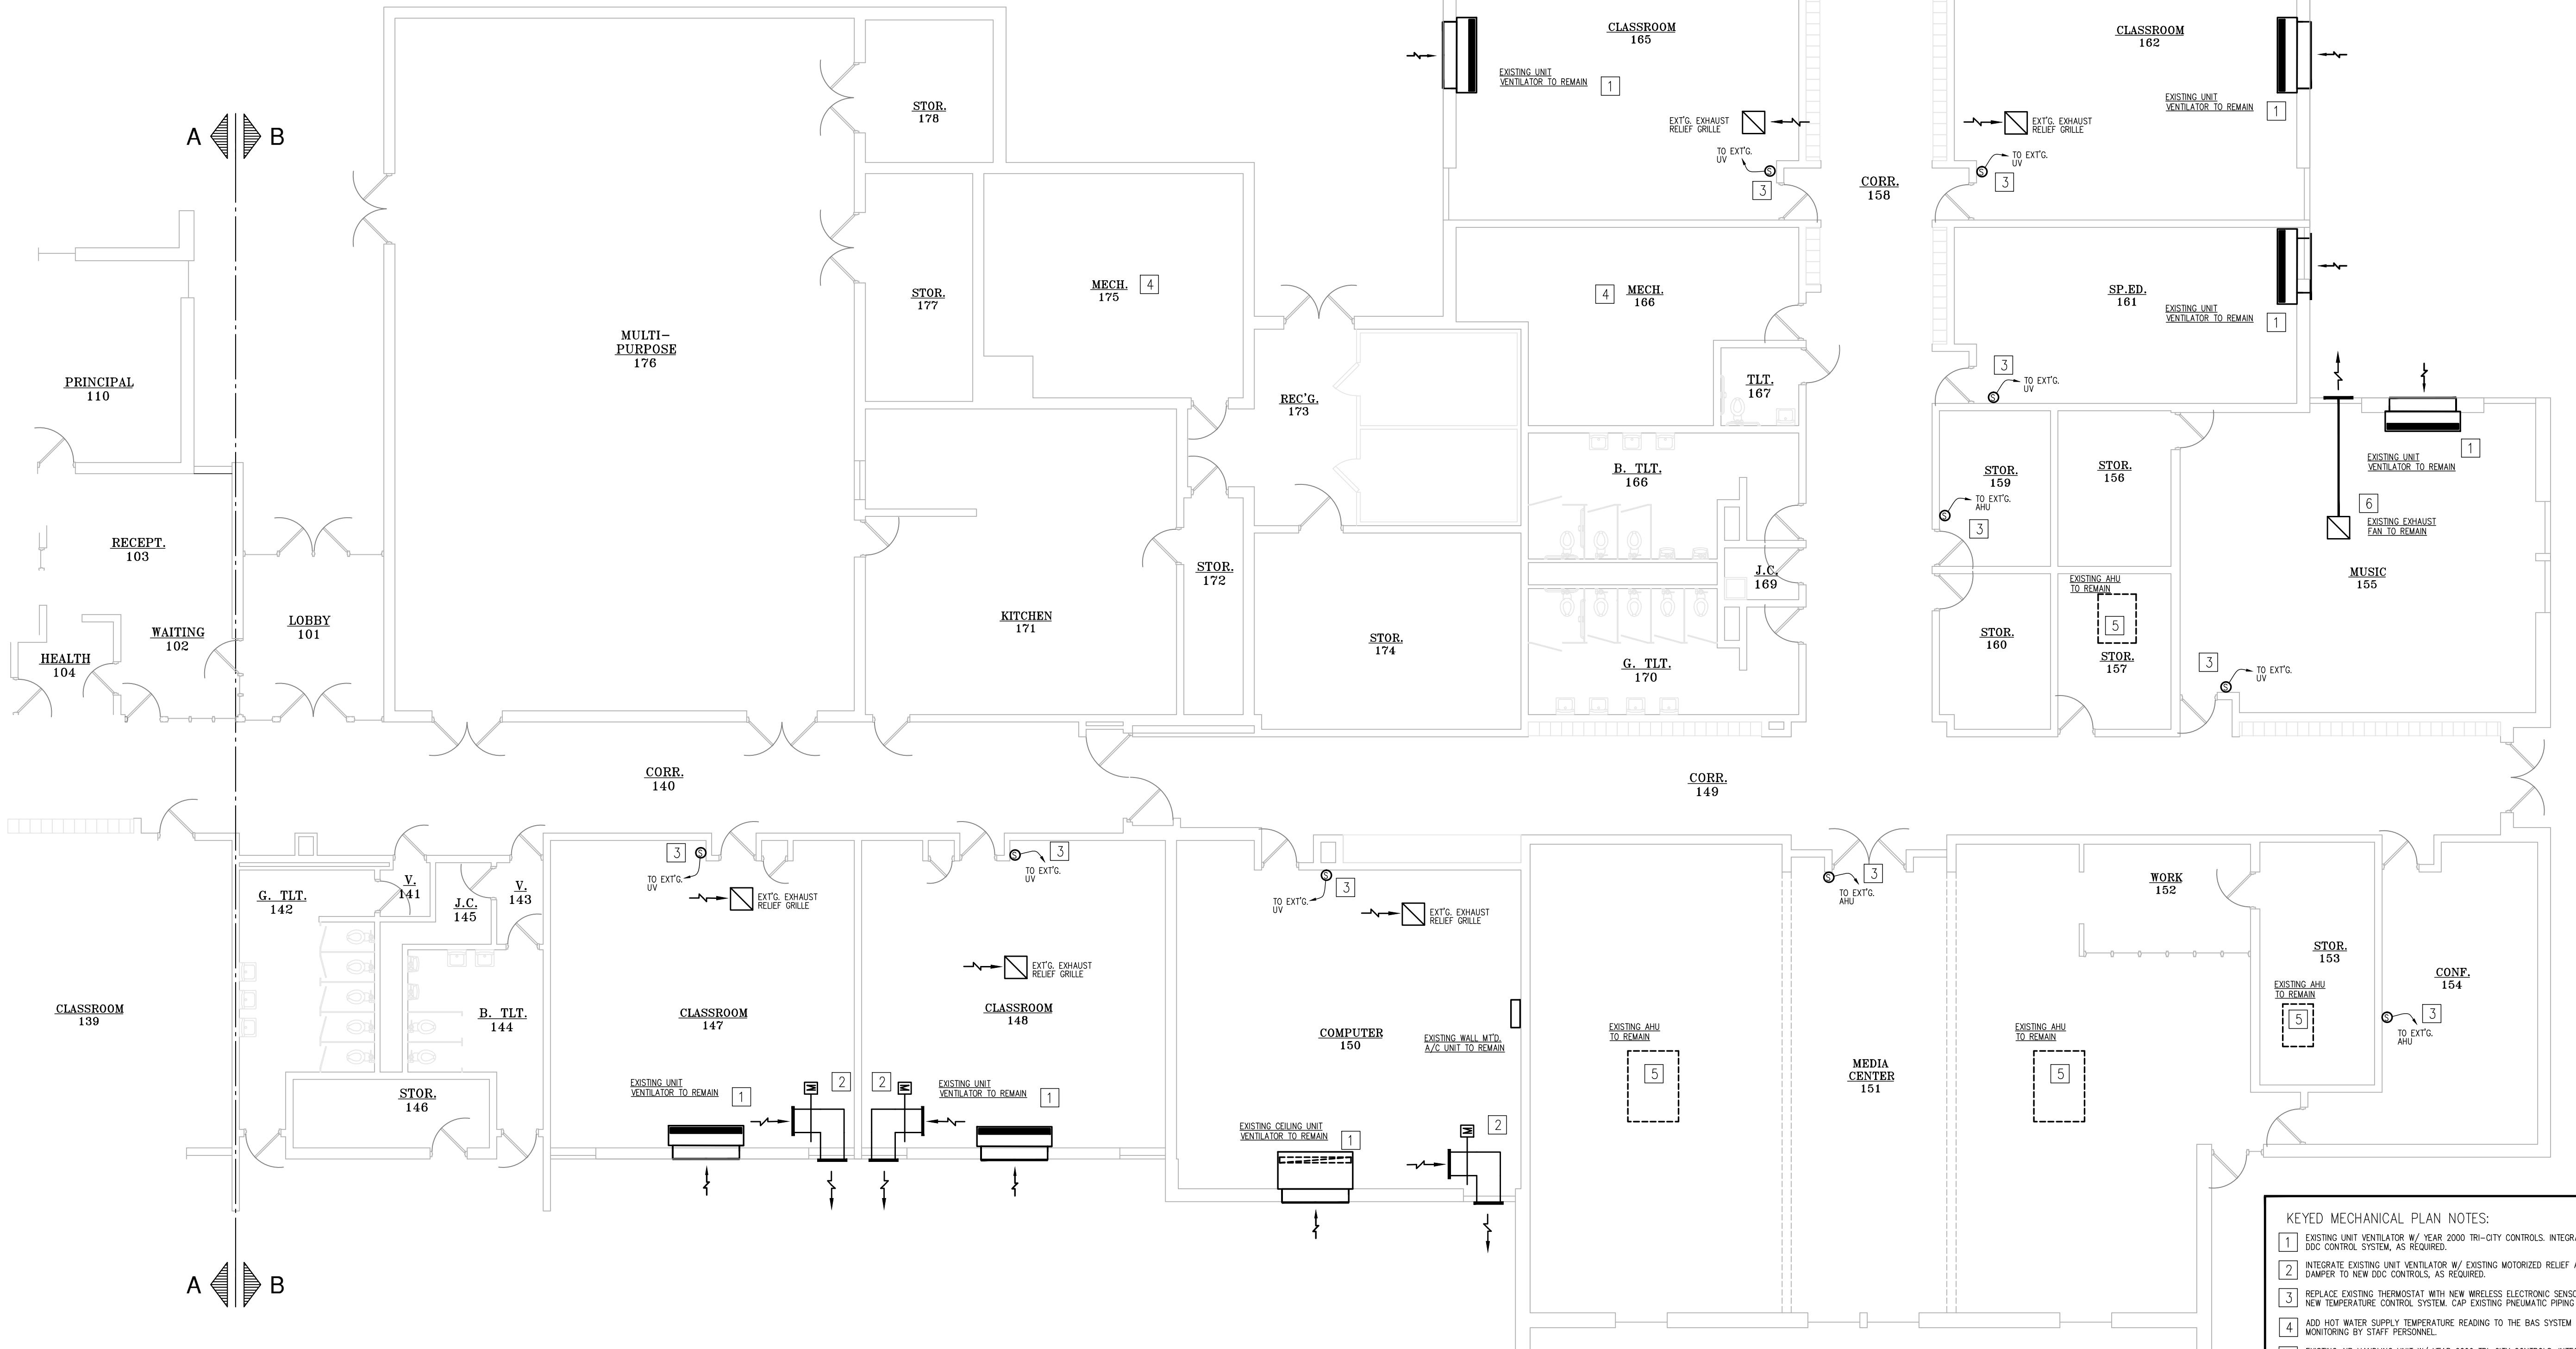

FLOOR PLAN PART "B" - MECHANICAL

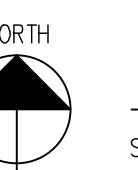

SCALE:

1" = 1'-0"

KEYED MECHANICAL PLAN NOTES:  
 1 EXISTING UNIT VENTILATOR TO REMAIN. YEAR 2000 TRI-CITY CONTROLS. INTEGRATE TO NEW DDC CONTROLS AS REQUIRED.  
 2 INTEGRATE EXISTING UNIT VENTILATOR W/ EXISTING MOTORIZED RELIEF DAMPER TO NEW DDC CONTROLS, AS REQUIRED.  
 3 REPLACE EXISTING THERMOSTAT WITH NEW WIRELESS ELECTRONIC SENSOR. CONNECT TO NEW TEMPERATURE CONTROL SYSTEM. CAP EXISTING PNEUMATIC PIPING IF APPLICABLE.  
 4 ADD HOT WATER SUPPLY TEMPERATURE READING TO THE BAS SYSTEM FOR REMOTE MONITORING BY STAFF PERSONNEL.  
 5 EXISTING AIR HANDLING UNIT W/ YEAR 2000 TRI-CITY CONTROLS. INTEGRATE TO NEW DDC CONTROL SYSTEM, AS REQUIRED.  
 6 INTEGRATE EXISTING UNIT VENTILATOR W/ EXISTING EXHAUST FAN TO NEW DDC CONTROLS, AS REQUIRED.

BUILDING BAS SYSTEM:  
 THE DIRECT DIGITAL CONTROL SYSTEM IS TO BE PROVIDED BY THE CONTRACTOR. THE CONTRACTOR GATEWAY HAS PROVIDED AND INSTALLED THE CARRIER I-VU BUILDING AUTOMATION SYSTEM UNDER A PREVIOUS CONTRACT. THIS PROJECT WILL BE USING THAT SYSTEM.

GENERAL MECHANICAL PLAN NOTES:  
 1. VERIFY OPERATIONAL CONDITION OF EXISTING EXHAUST FANS AND NOTIFY THE G.C. OF ANY PROBLEMS AND SUGGESTED SOLUTION.  
 2. VERIFY OPERATIONAL CONDITION OF EXISTING MOTORIZED DAMPERS AND NOTIFY THE G.C. OF ANY PROBLEMS AND SUGGESTED SOLUTION.